31-33 Shepherd Street Liverpool

Landscape Development Application

DRAWINGS

DWG NO.	DRAWING TITLE	SCALE
000	Cover sheet	
C100 100	Color Landscape Composite Plan Landscape Composite Plan	1:200 1:200
101 102 103	Landscape Plan - Ground Floor Landscape Plan - Building A Level 21 Roof Terrace Landscape Plan - Building B Level 27 Roof Terrace	1:200 1:100 1:100
201 202 203	Landscape Planting Plan - Ground Floor Landscape Planting Plan - Building A Level 21 Roof Terrace Landscape Planting Plan - Building B Level 27 Roof Terrace	1:200 1:100 1:100
500 501	Landscape specification notes & Plant schedule Landscape details	As shown

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 05.04.2023

 E
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 03.03.2023

 D
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 PH
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 13.02.2023

 C
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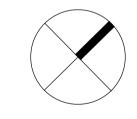
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 16.01.2023

 A
 For Approval
 PH
 RS
 23.11.2022

 Issue
 Revision Description
 Drawn
 Check
 Date

Legend

Key Plan



Client

Lateral Estate

Project

31-33 SHEPHERD STREET LIVERPOOL

SITE IMAGE

Level 1, 3-5 Baptist Street Redfern NSW 2016 Australia

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DEVELOPMENT APPLICATION

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Cover Sheet

Scale Job Number


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Proposed Groundcover

Seating

Bollards

Entry Plaza Feature Paving

Pit & Underground Pipes - Refer Engineer's drawing

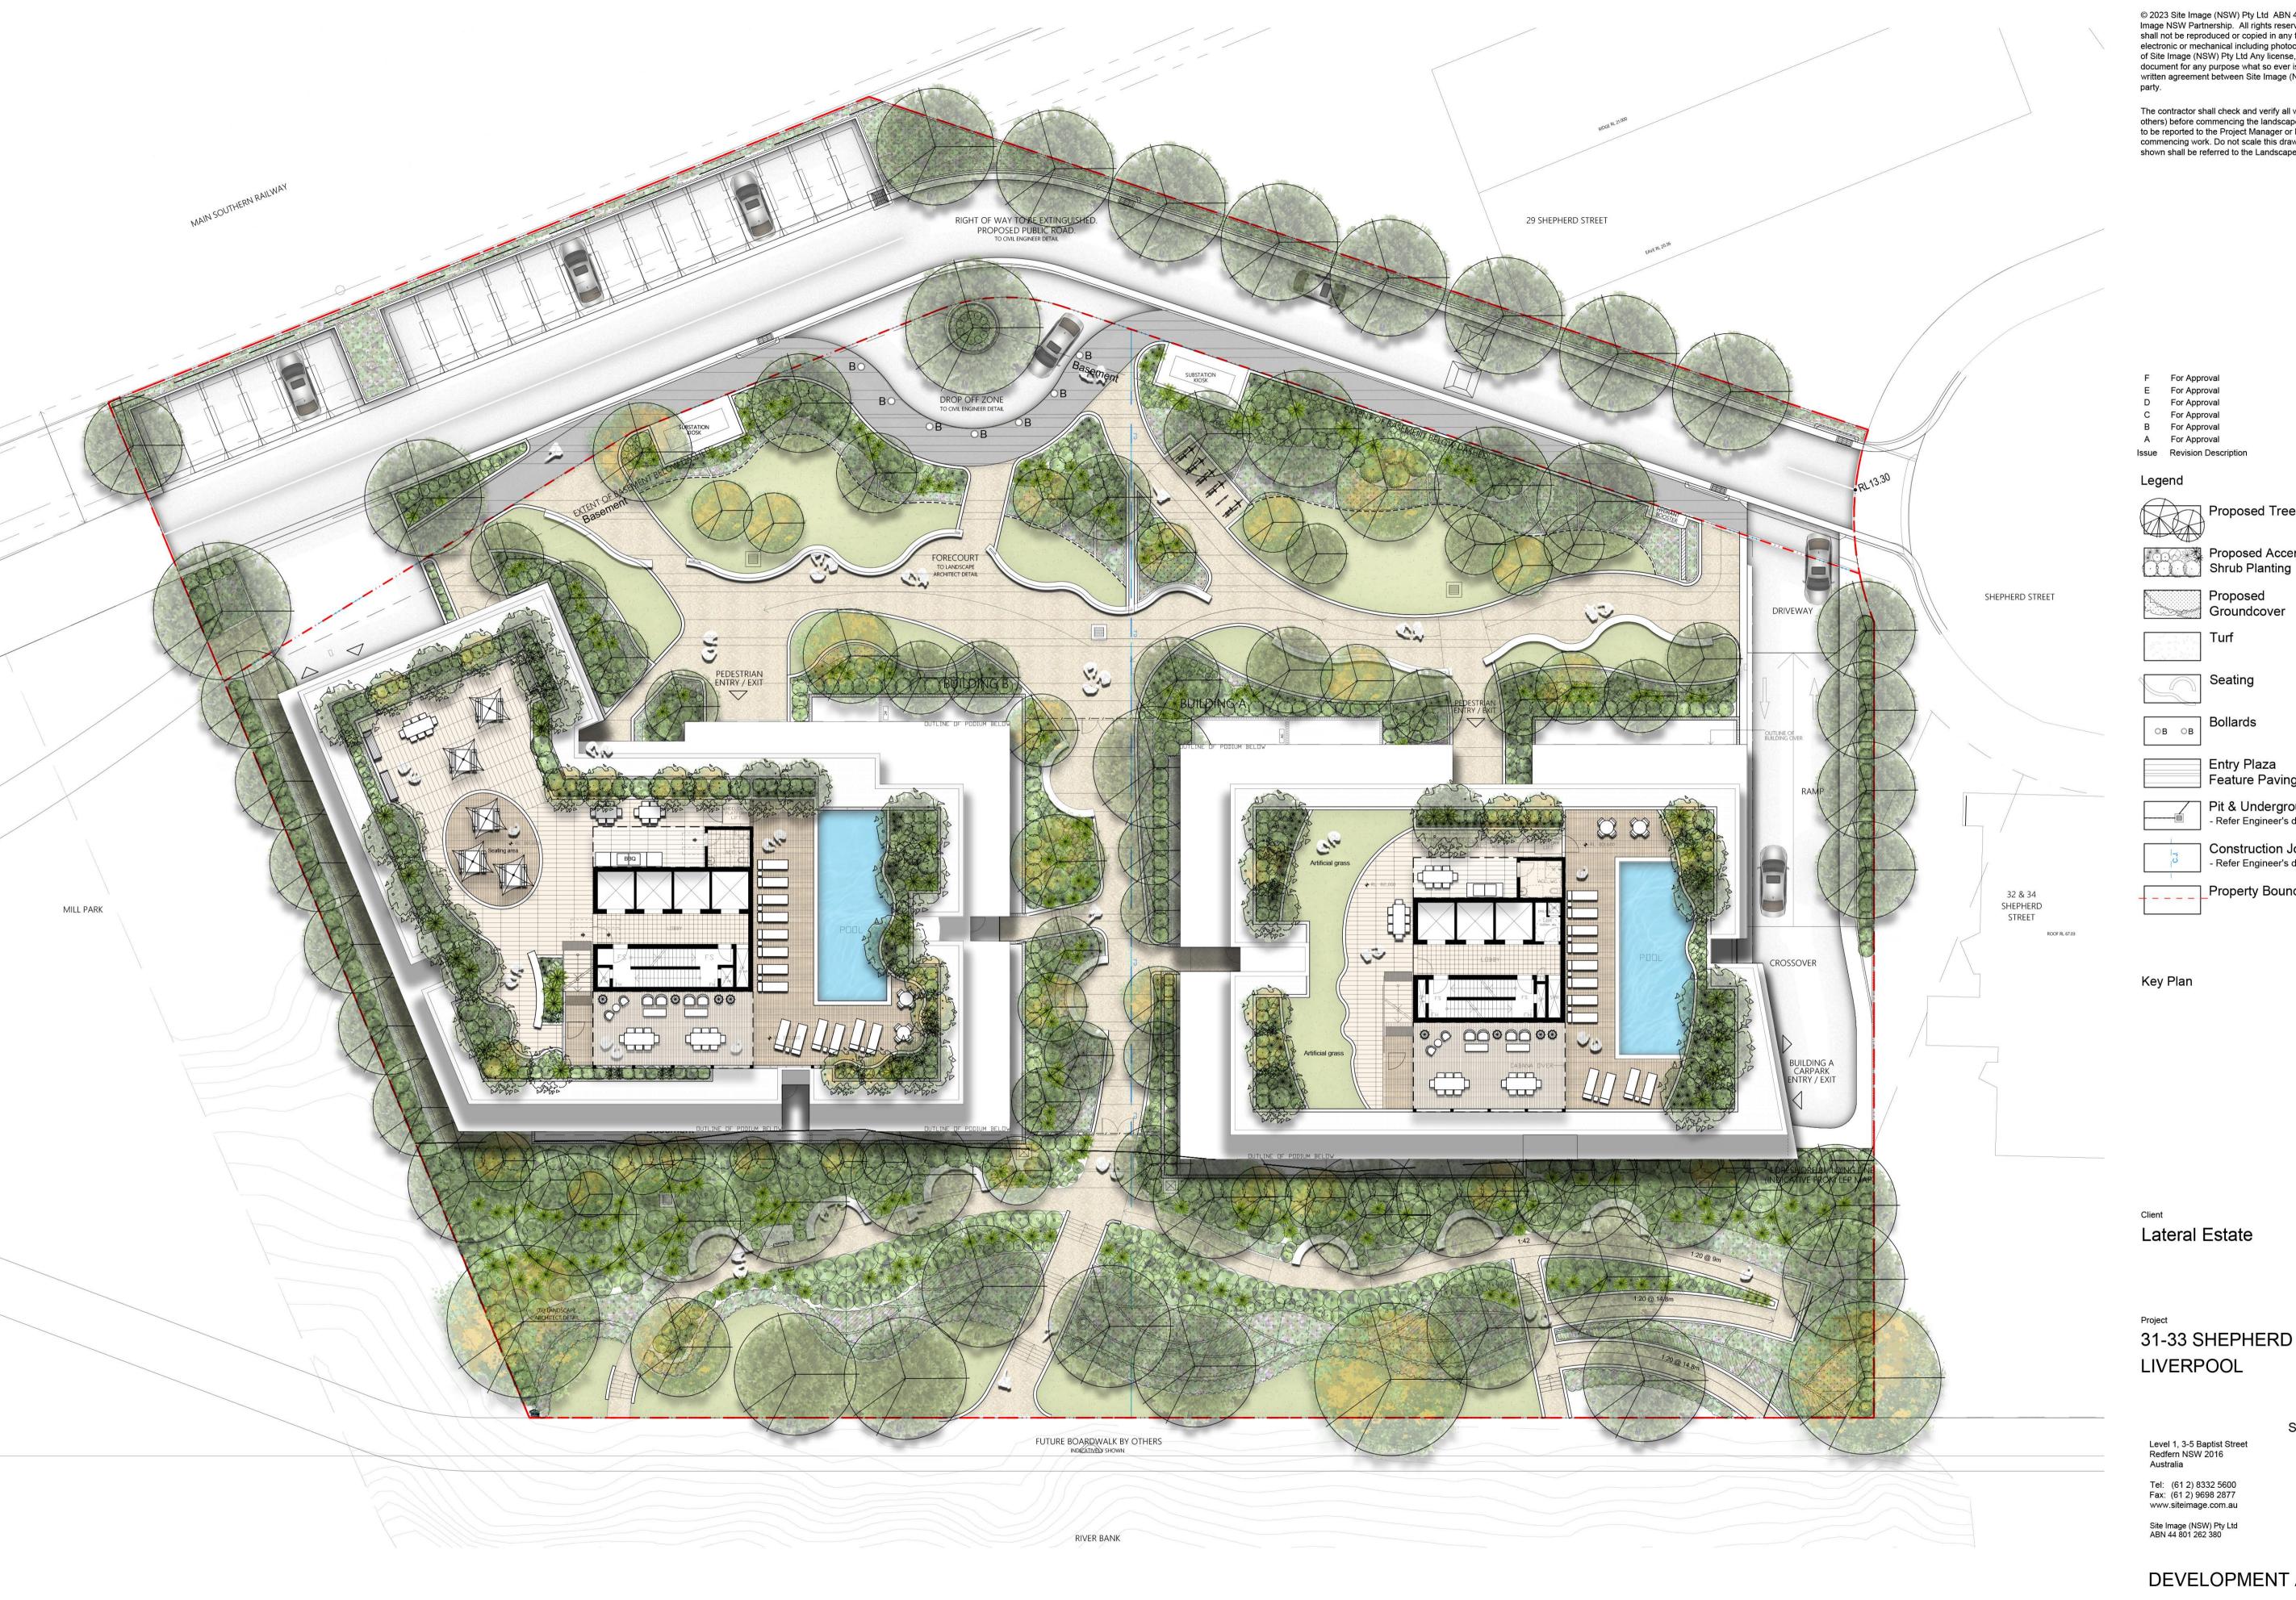Construction Joint - Refer Engineer's drawing Property Boundary



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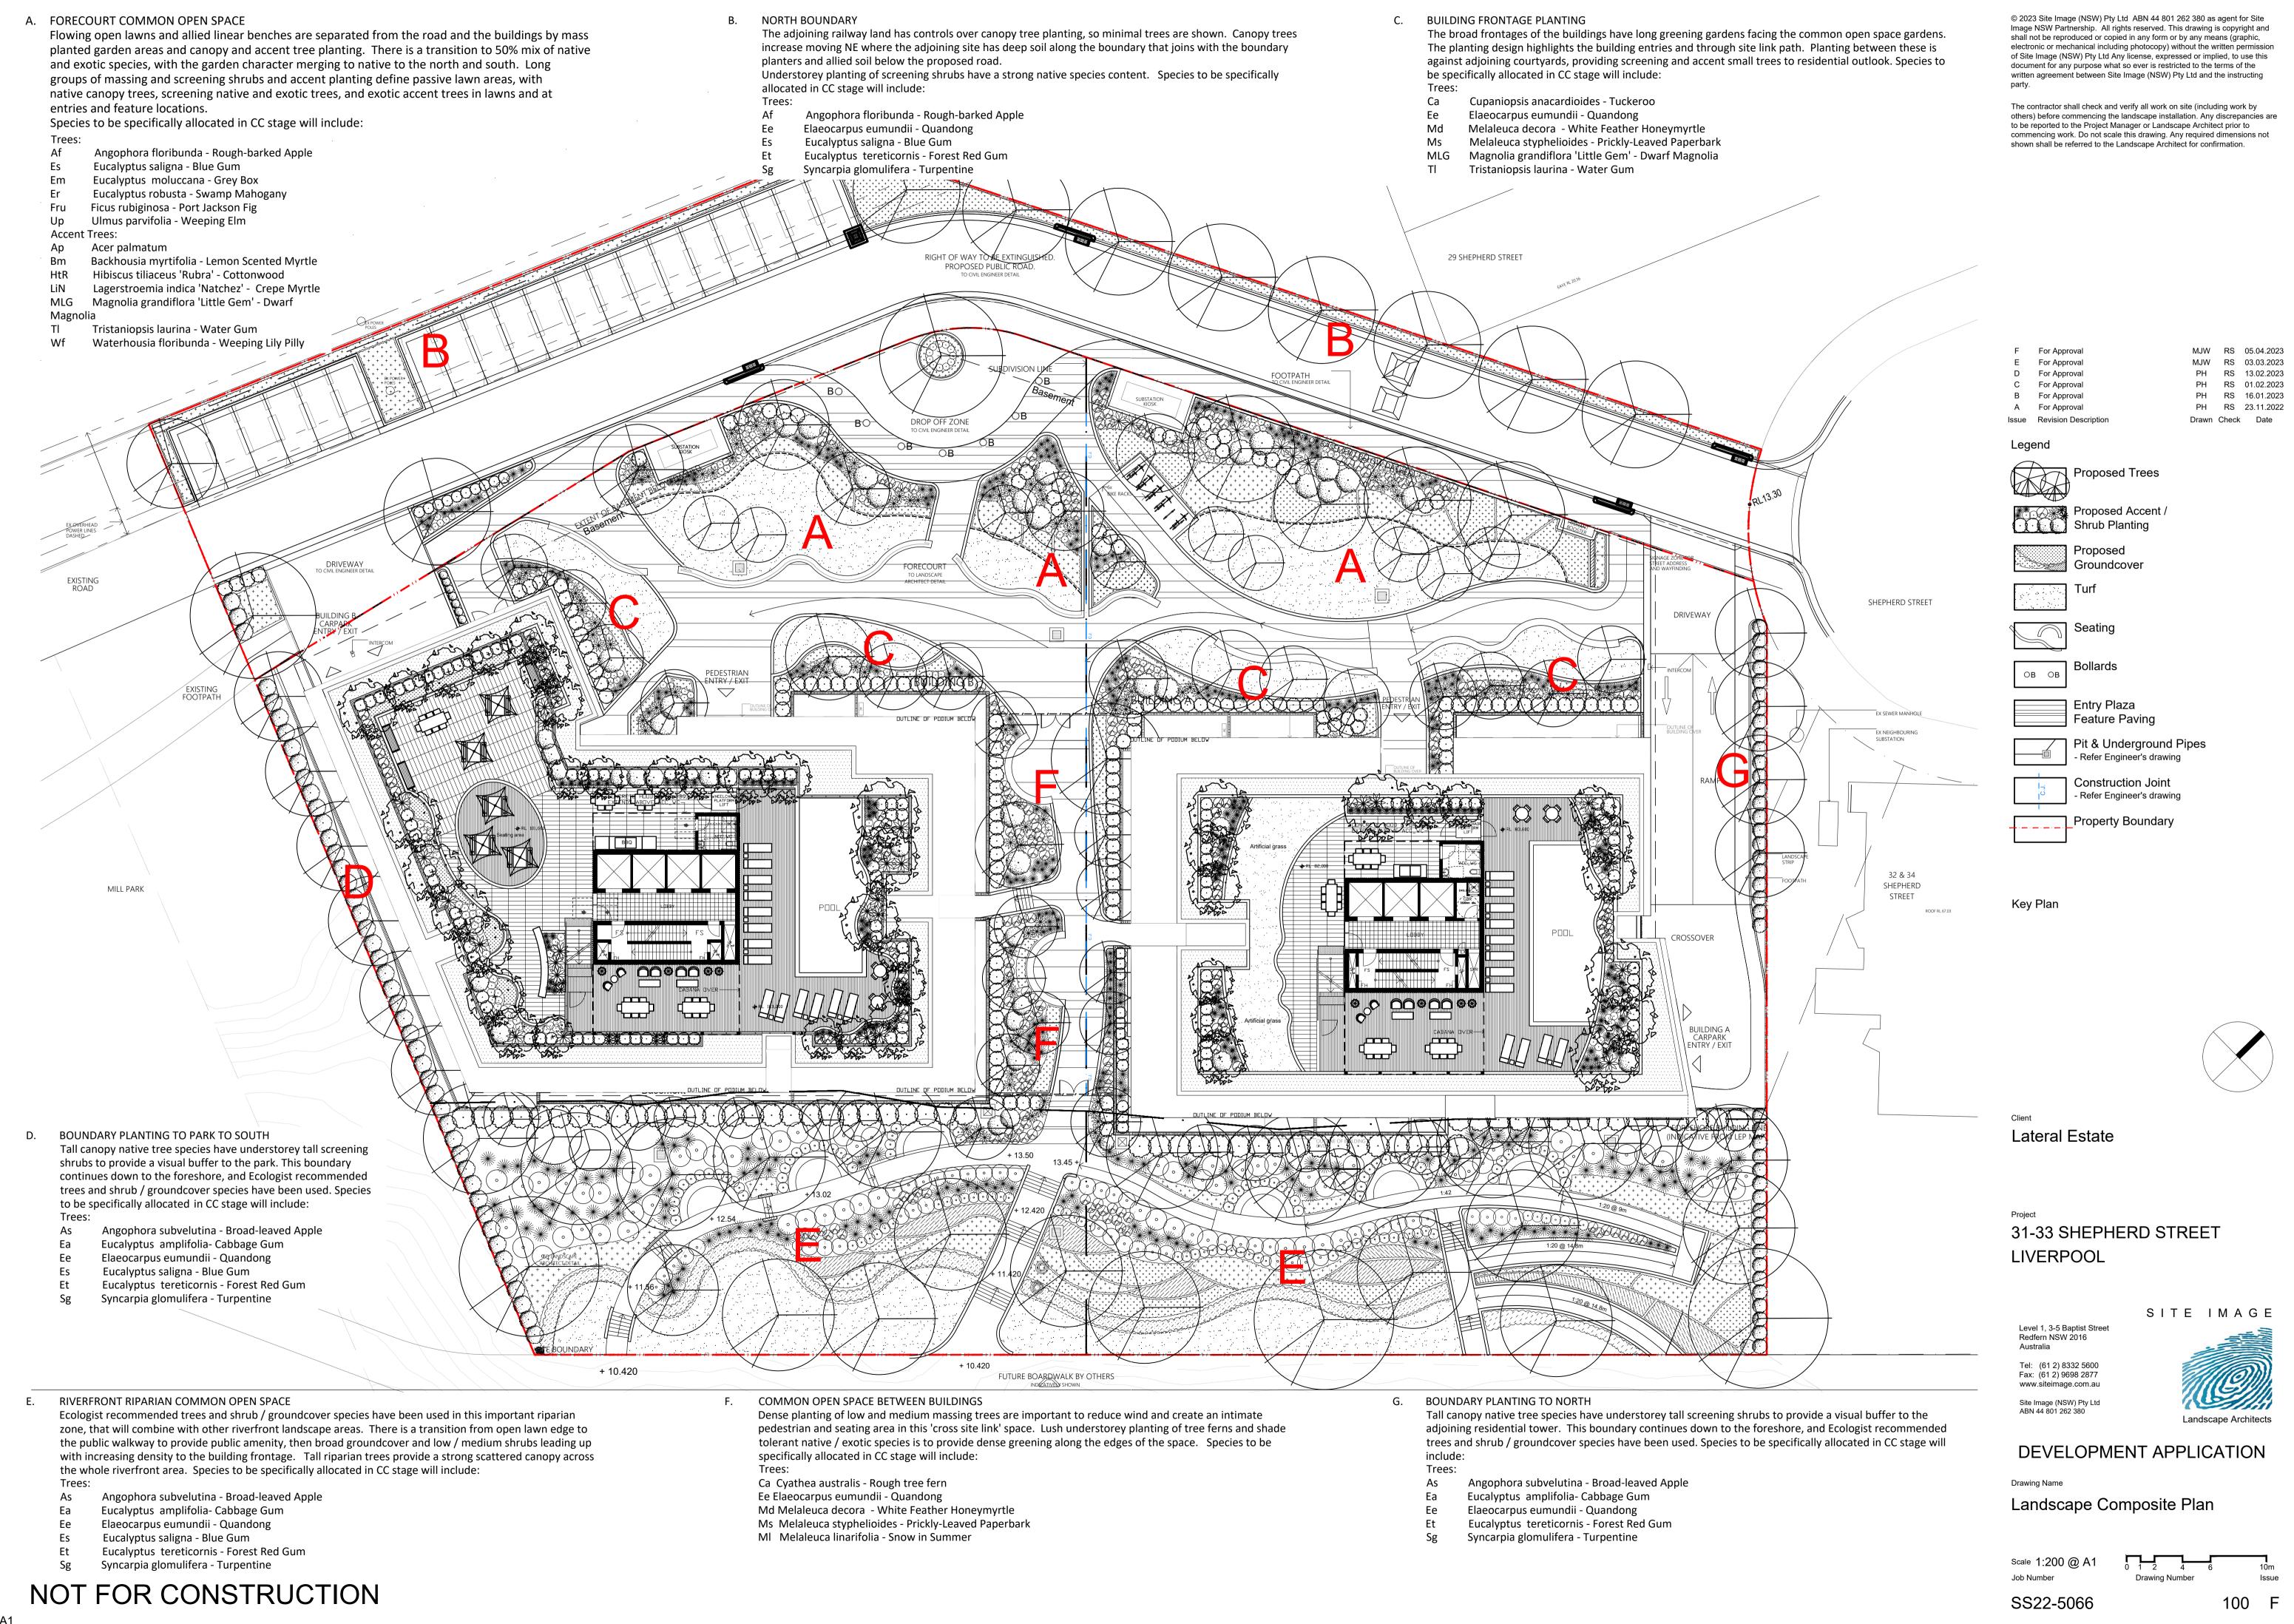



DEVELOPMENT APPLICATION

Color Landscape Composite Plan

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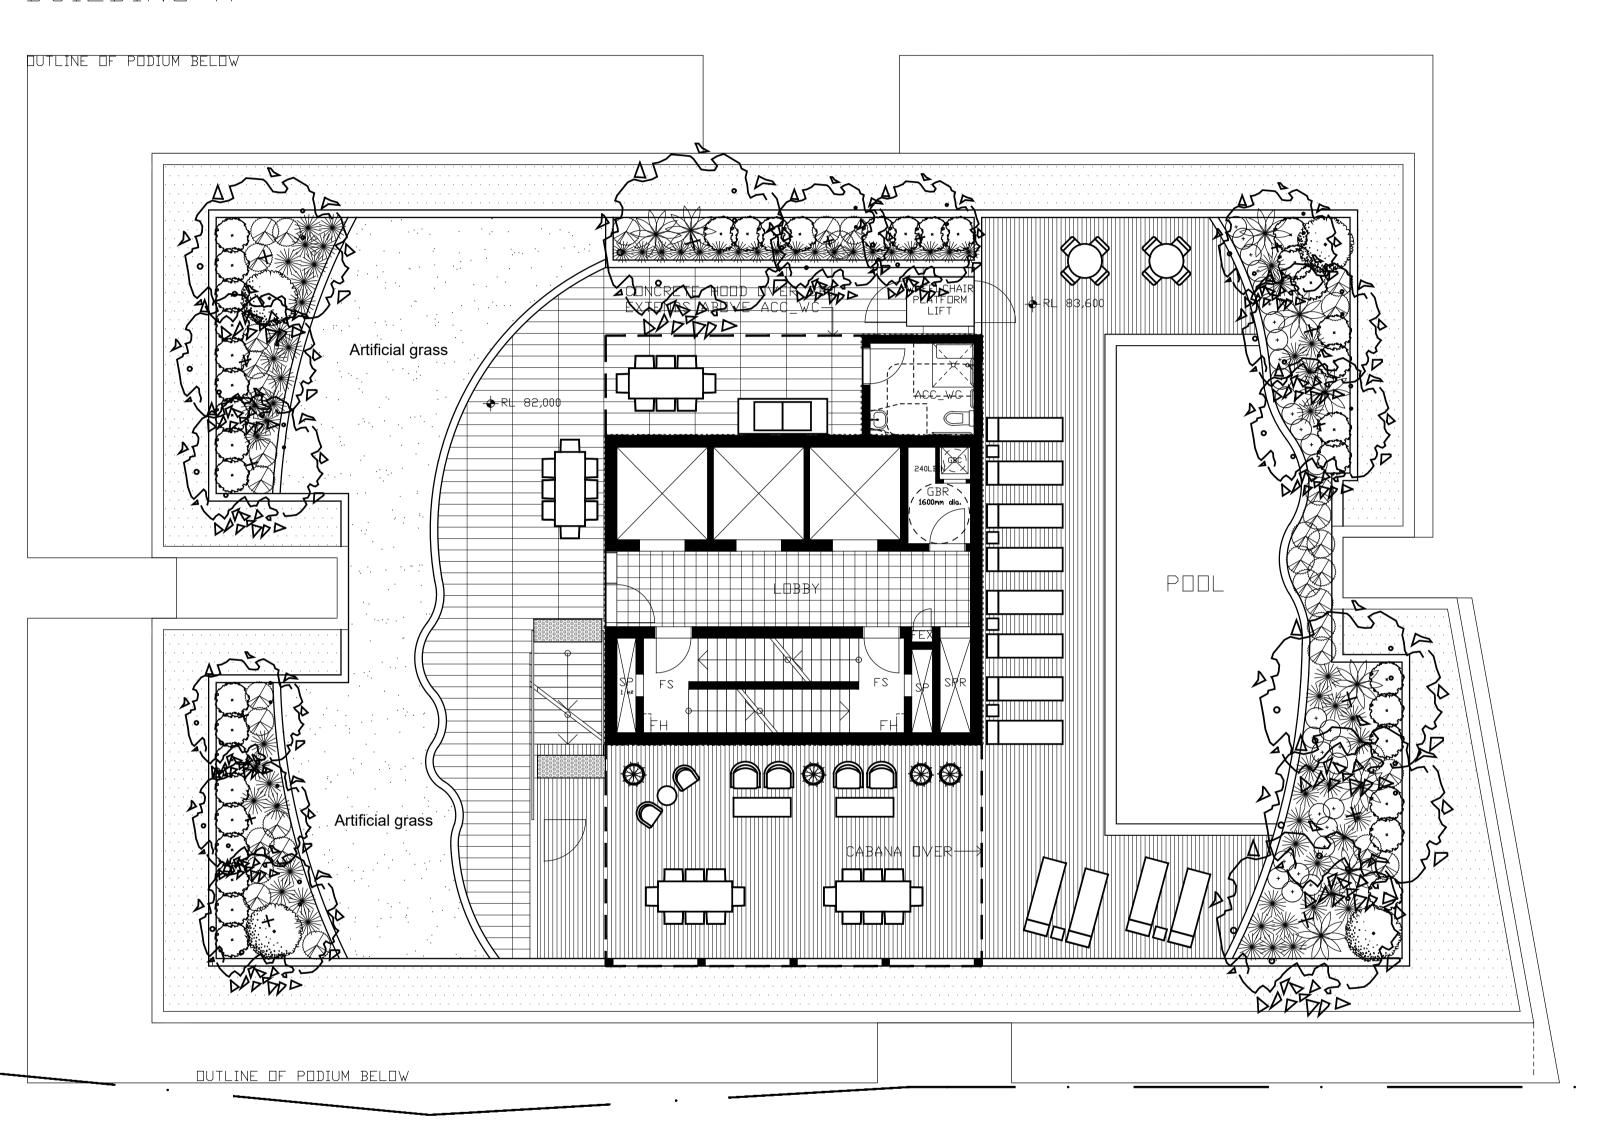


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BUILDING A

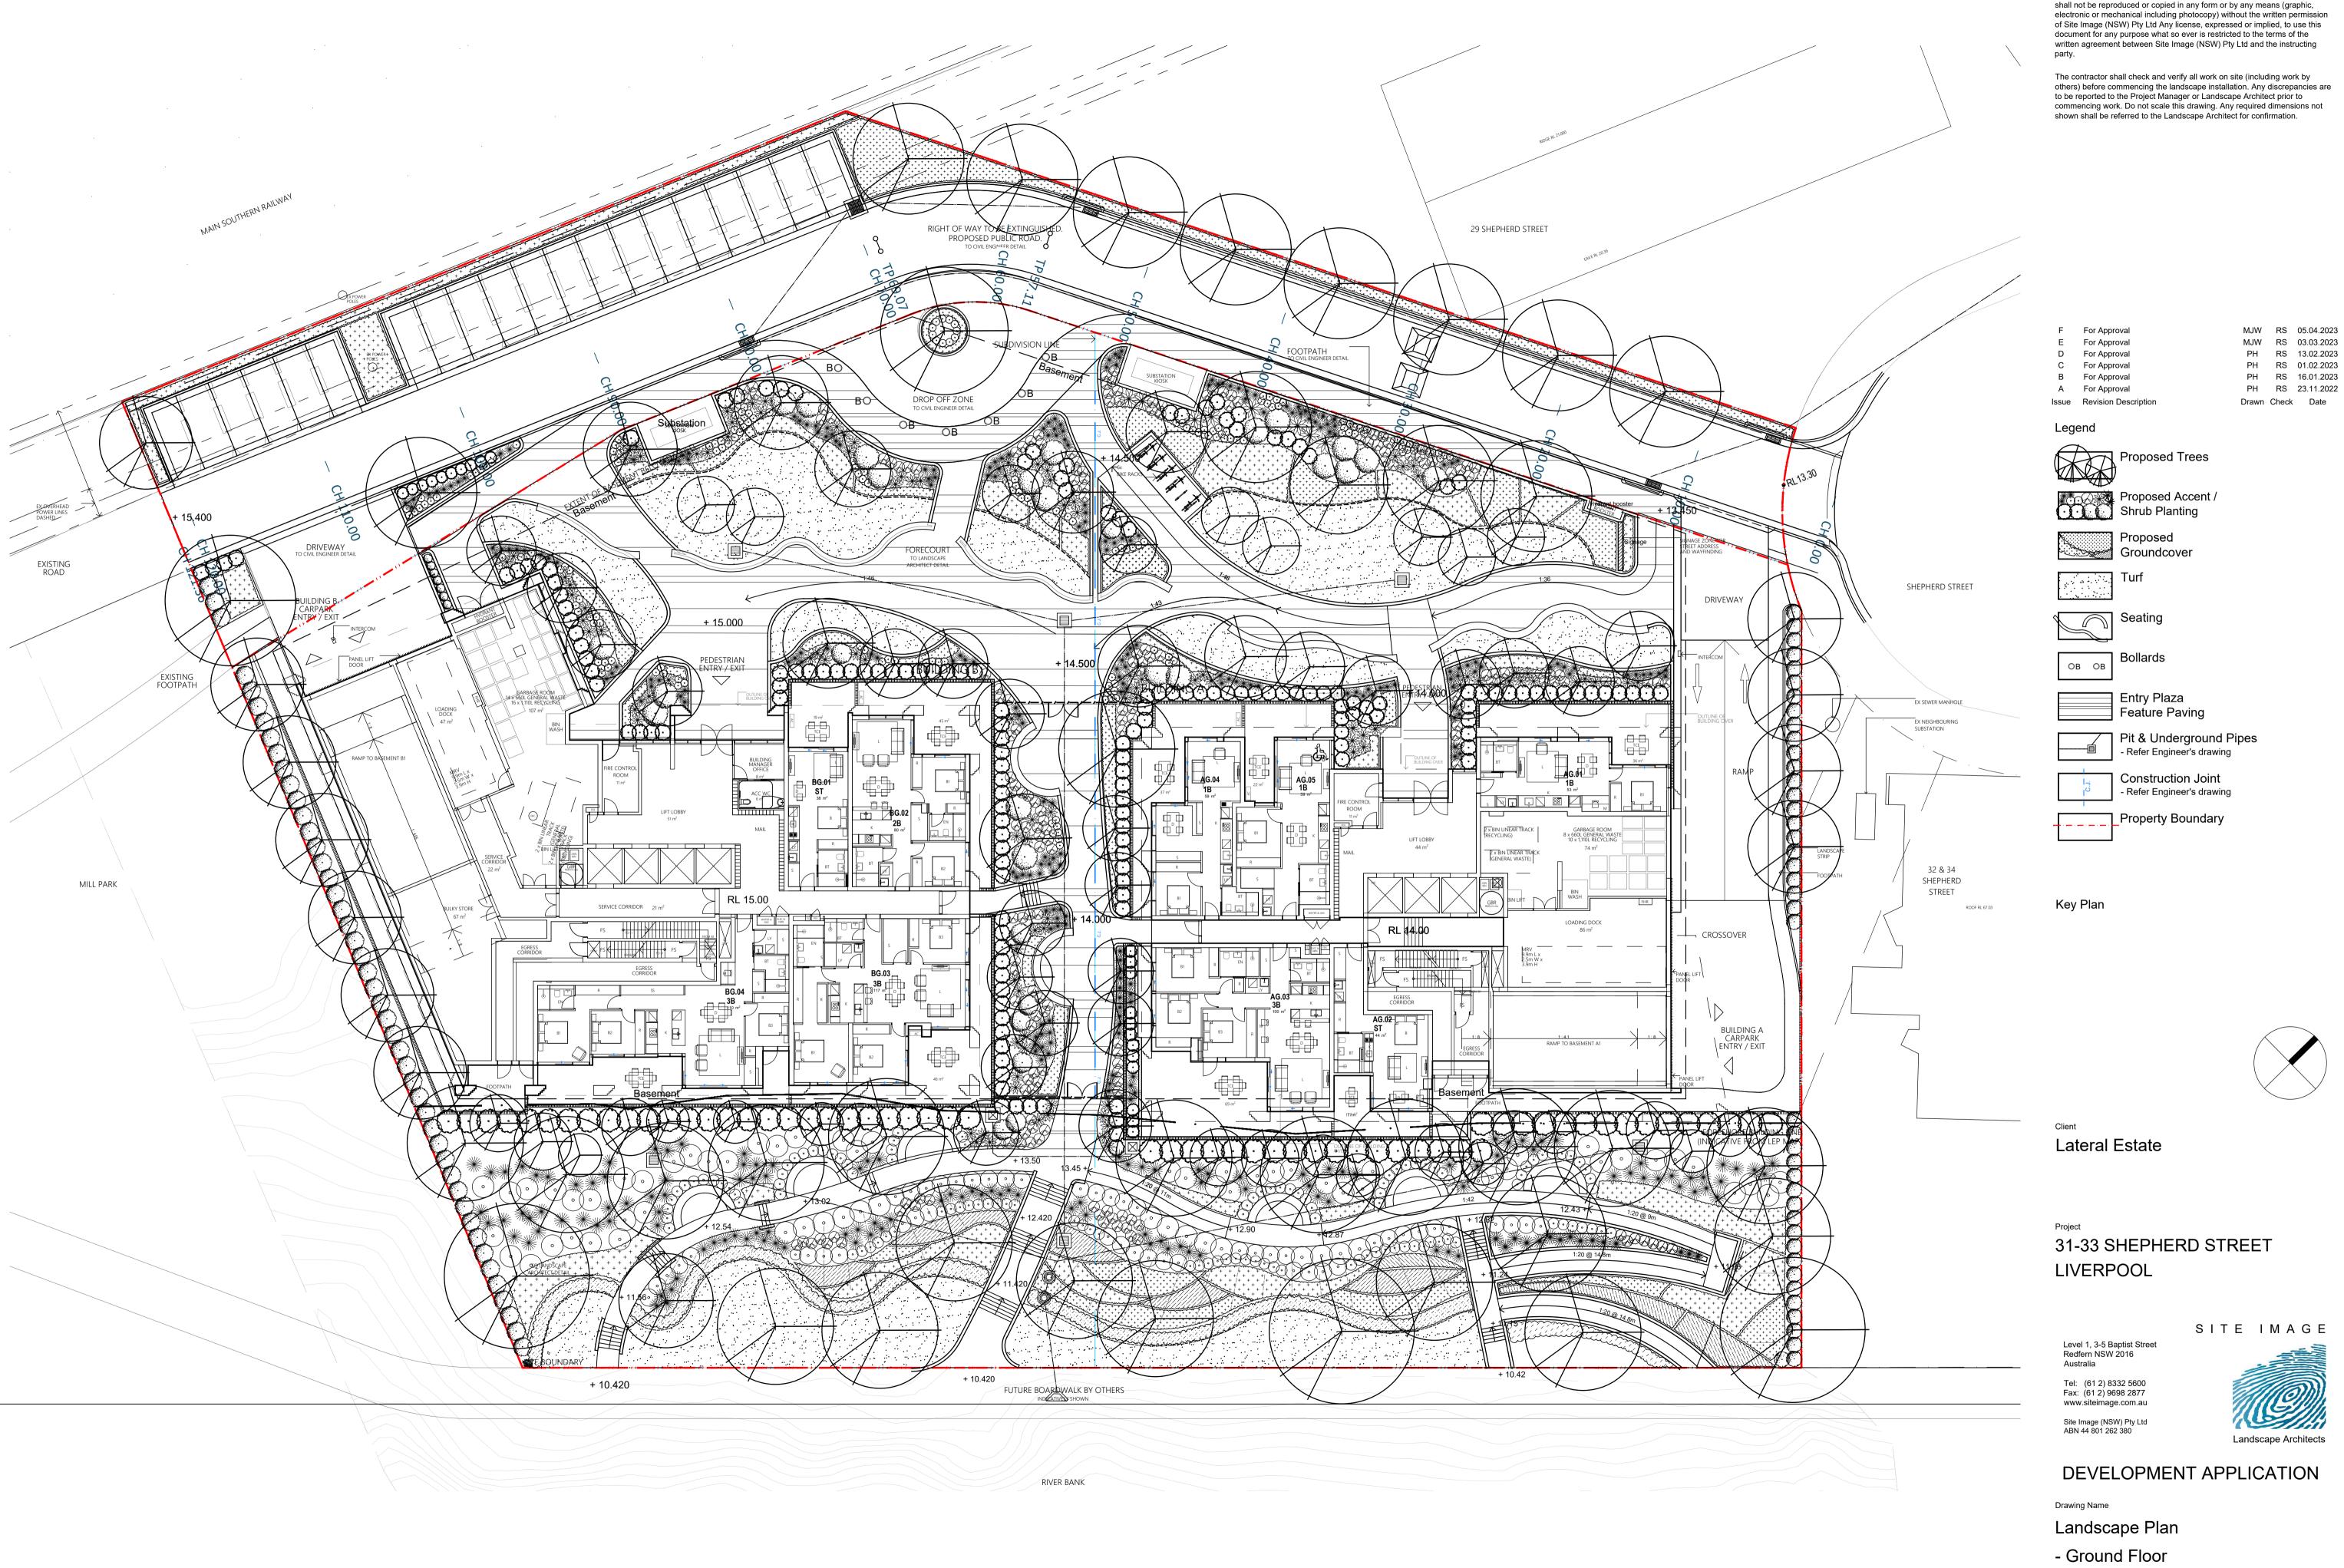


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DEVELOPMENT APPLICATION

Drawing Name

Landscape Plan

- Building A Level 21 Roof Terrace

Scale 1:100 @ A1 0 1 2 3 4 5m
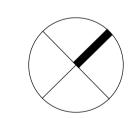
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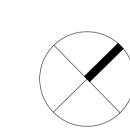
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DEVELOPMENT APPLICATION

Drawing Name

Landscape Plan

- Building B Level 27 Roof Terrace


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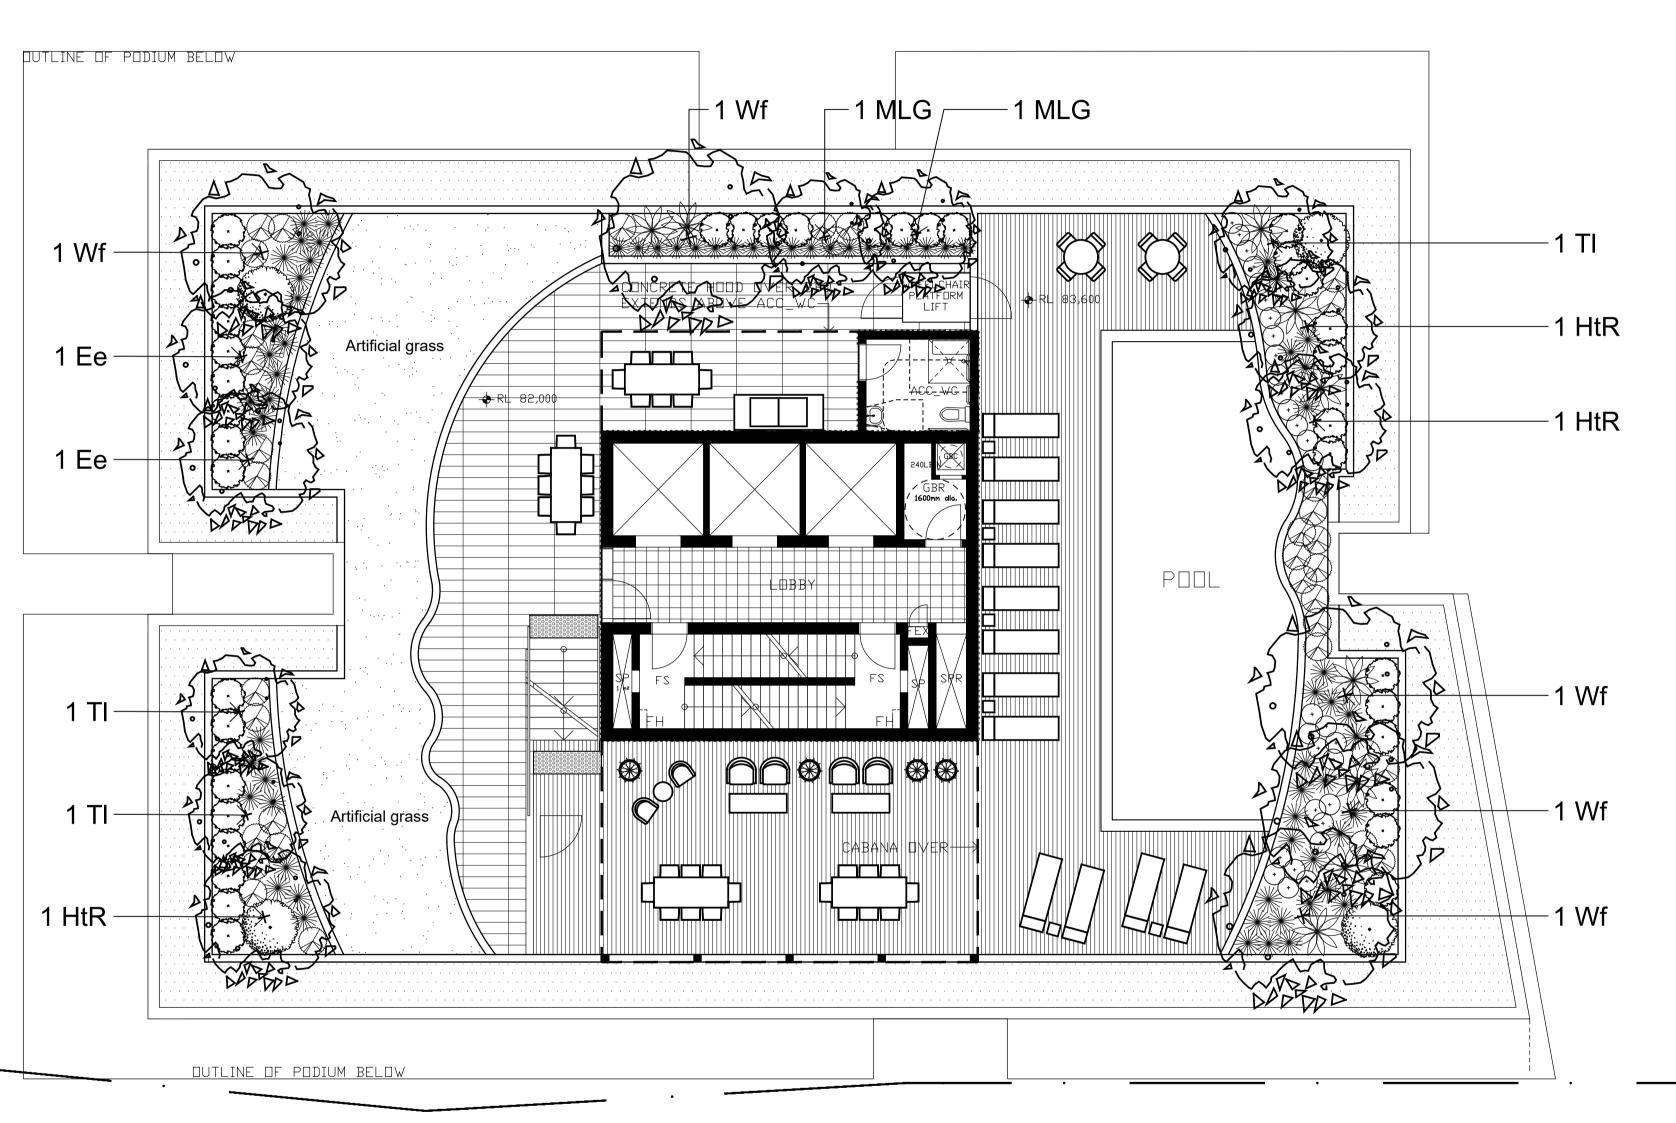
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BUILDING A



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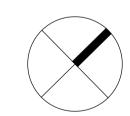
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DEVELOPMENT APPLICATION

Drawing Name

Landscape Planting Plan

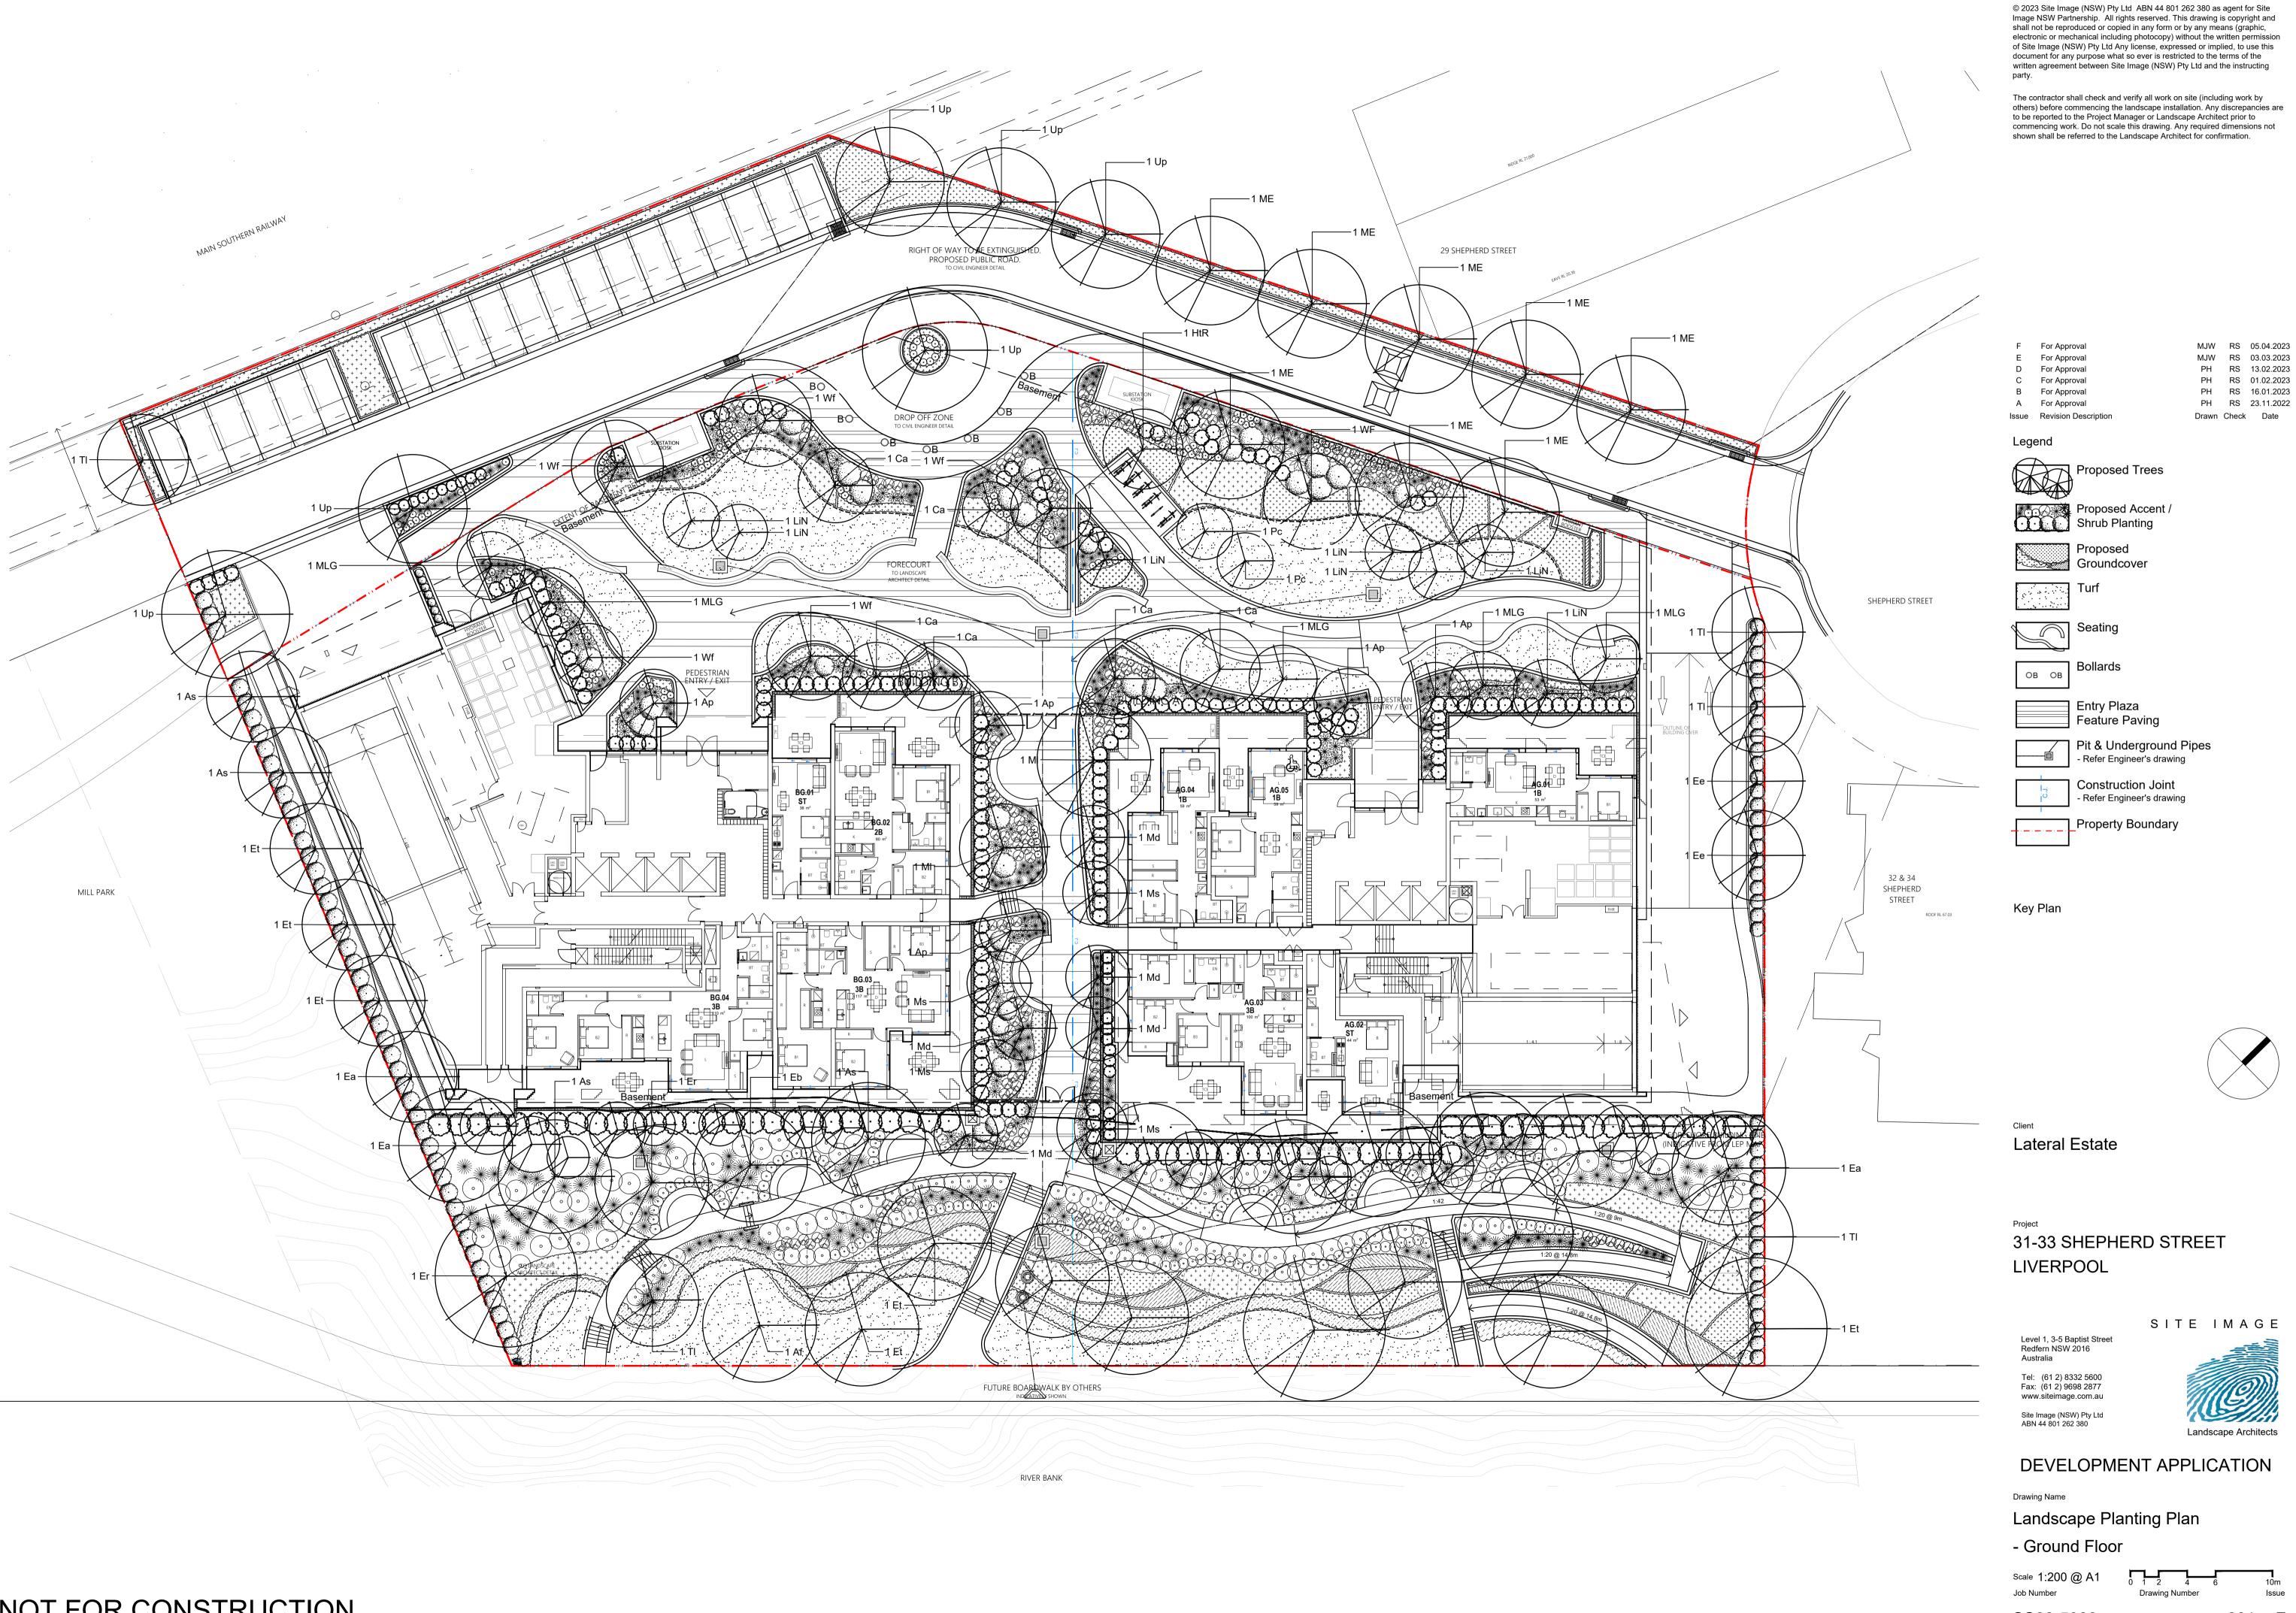- Building A Level 21 Roof Terrace

Scale 1:100 @ A1 0 1 2 3 4 5m

Job Number Drawing Number Issue

SS22-5066 202 F

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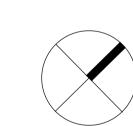
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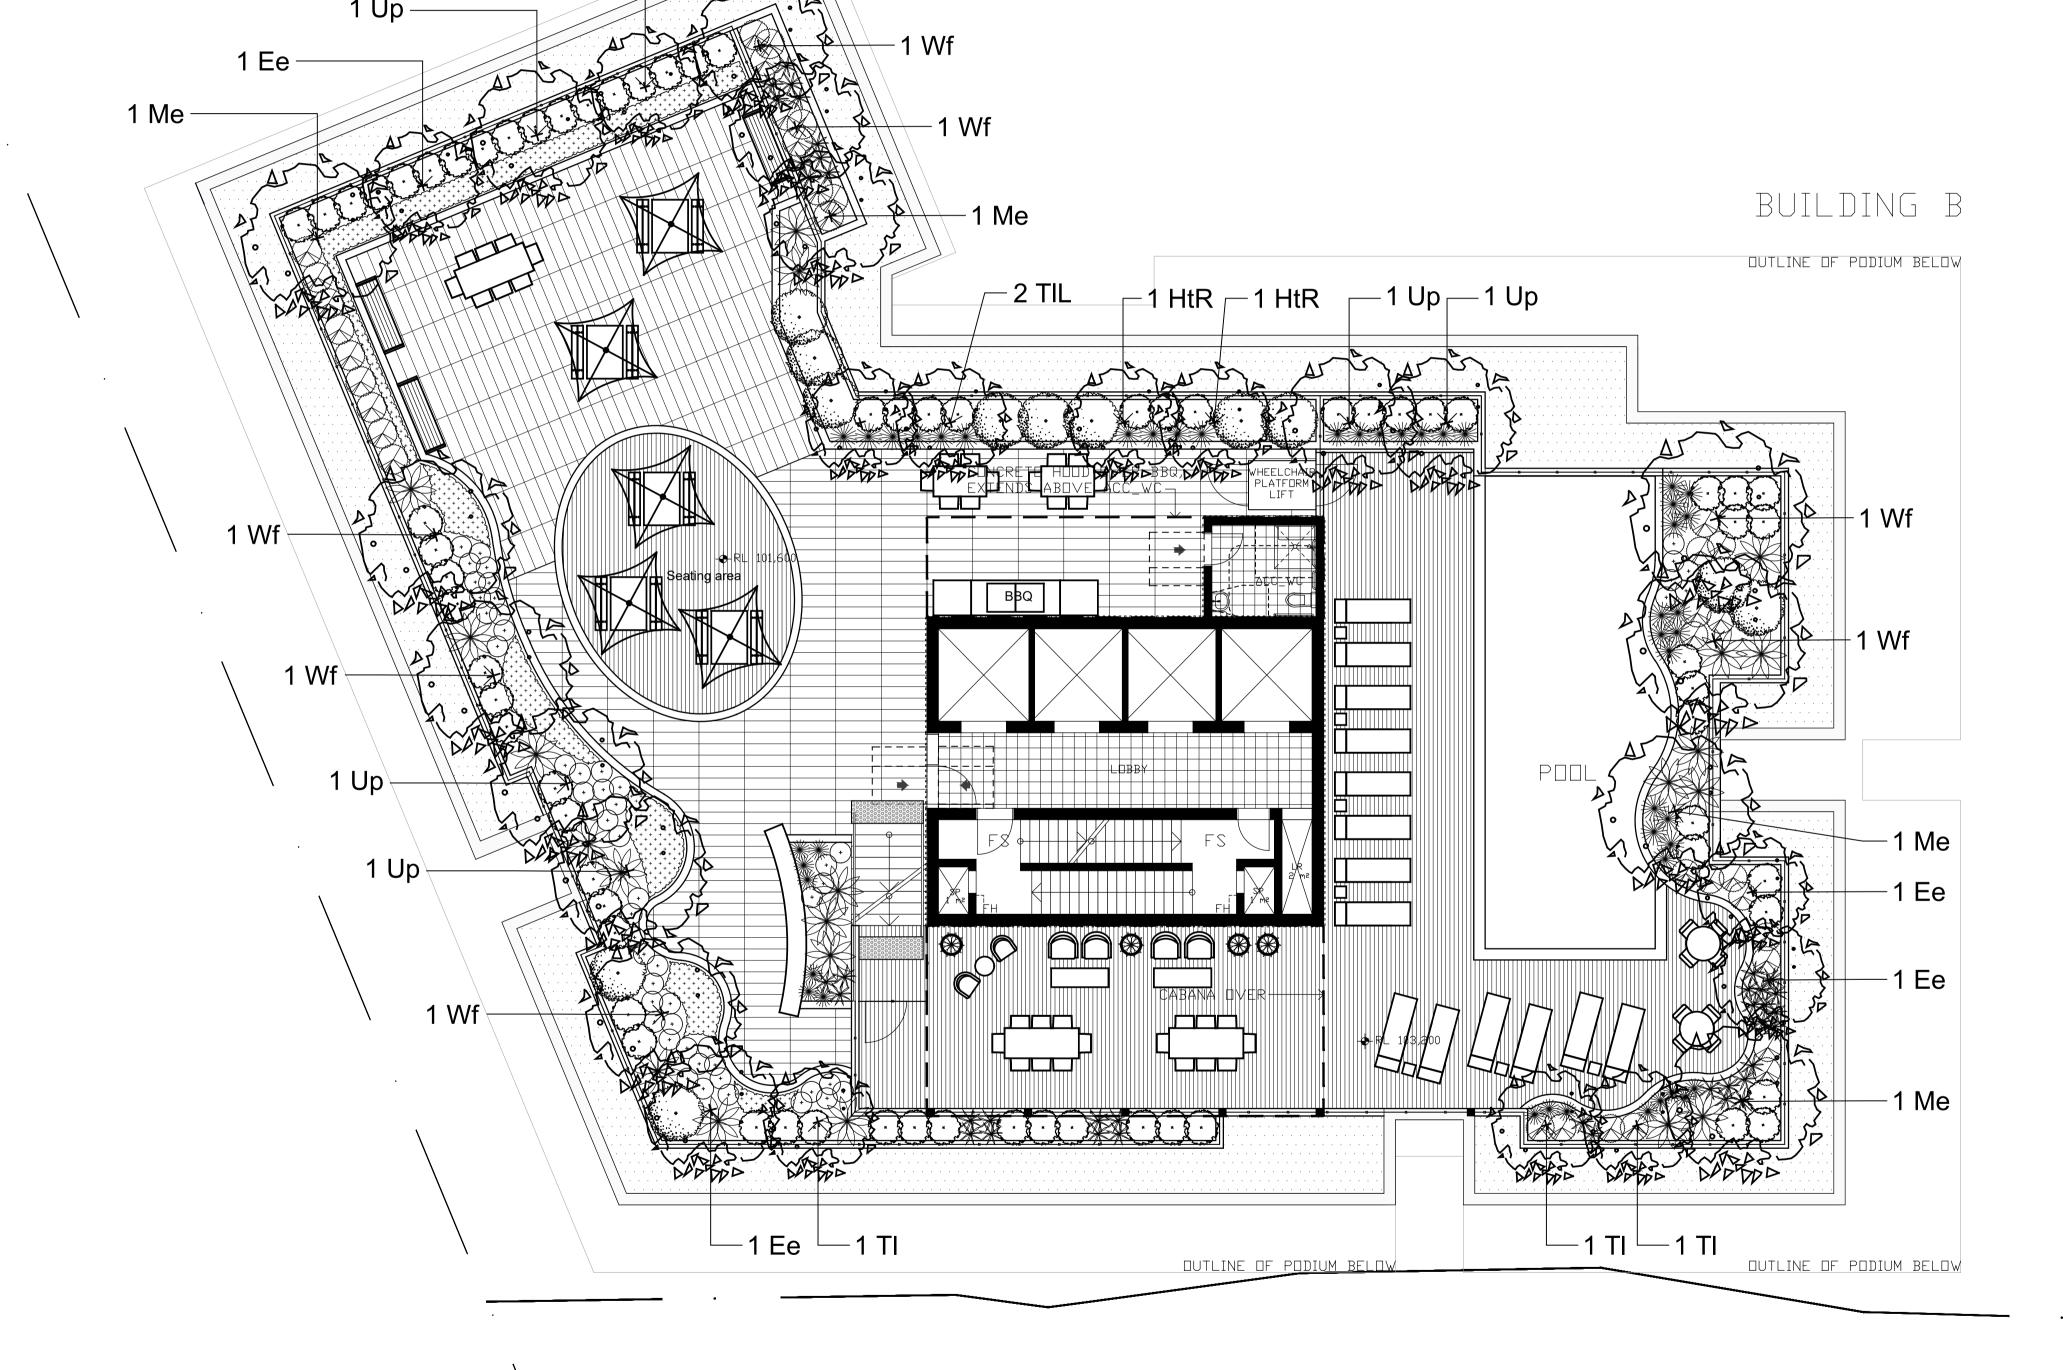


DEVELOPMENT APPLICATION

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Landscape Planting Plan

- Building B Level 27 Roof Terrace



SPECIFICATION NOTES

GENERAL NOTES

References

All plans and details included in the project documents shall be read in conjunction with this specification. All structural and civil works components of the landscape design shall be referenced to engineers' details and specifications. Read this specification in conjunction with the plant and materials schedules on the drawings. If in doubt about any detail or if conflicts are found in the documents, seek advice.

Workmanship and Materials

The whole of the landscape works shall be carried out by a competent, trained and qualified landscape contractor who is experienced in horticultural practices, landscape construction and planting techniques. The landscape contractor shall hold a current Building Contractors License and/or be a financial member of LNA Landscape Association NSW & ACT or equivalent organisations in other states.

EXISTING TREES AND SHRUBS

Trees and Shrubs to be Retained and Protected

Identify and mark trees and shrubs to be retained using a suitable non-injurious, easily visible and removable means of identification. Protect from damage the trees and shrubs to be retained, including those beyond the site area, both above and below the ground. If a tree becomes damaged during the works or it is proposed to perform work on a tree, give written notice immediately and obtain instructions.

Work Near Trees and Shrubs

Keep the area of the drip-line free from construction material and debris. Do not place bulk materials and harmful materials under foliage canopies or near trees. Do not place spoil from excavations against tree trunks. Prevent wind-blown building materials, such as cement, from covering trees and other plants. Do not remove topsoil from, or add topsoil to, the area within the drip-line of trees

EARTHWORKS

Excavation, Trimming and Filling

Except as otherwise noted in the contract, bulk excavation is excluded from the landscape works. After the completion of bulk excavation by others, trim and fill the excavated ground surfaces to achieve design levels to accommodate finish materials as detailed. Prepare the sub-grade surface as required for the various finished ground treatments.

Site Drainage

Keep the excavated works drained and free of standing water. Allow to supply and install sub-soil drainage pipes as required for the new works to ensure that all gardens are well drained. Connect the sub-soil drainage pipes to the nearest downstream stormwater pits. Include pipe filter socks and course sharp aggregate backfilling of trenches.

HARDWORKS

Furniture, Handrails, Balustrades

Supply and install the scheduled items in accordance with the manufacturer's recommendations, as detailed and in the locations shown on plan. Provide all footings and fixings required for the items to be stable and in accordance with applicable codes and standards.

- Balustrades: Equal to Stainform ONYX 50 316 Satin SS
- Handrails: Equal to Stainform ONYX 50 316 Satin SS
- Bench Seats: Teak timber TBS

Garden Walls, Fences, Steps, TGSI and Edging

Construct garden walls, fences, steps, TGSI and edging as shown on plan, as detailed and of the material scheduled. Provide footings, step nosings, tactile surfaces to comply with Australian Standards and applicable legislation. Refer to engineer's details for structural retaining walls, concrete stairs, concrete strength, reinforcing and joint placement.

Continuous, Unit and Loose Pavement

Install the scheduled material pavement to the locations shown on plan. Ensure that all subgrade/subsurface works are complete prior to commencing paving. Confer with the engineer to ensure the structural integrity of the subgrade. Ensure that the base course under paved surfaces is a continuous plane offering a constant depth of bedding material not exceeding 50mm. If laying unit pavers in a cement mortar bed on a concrete sub-base ensure that joints in paving match the location of joints in the concrete. Refer to engineer's details for heavy duty slabs, concrete stairs, concrete strength,

- reinforcing, and joint type and placement. Insitu concrete paths: Wood float coved finish, tool edged.
- Path joints: Construction joints at 3000mm centres max

Landscape Structures

All landscape structures shall have a common appearance in detail and material content while providing for the functional design requirements. The structure of all elements shall consist of a base frame of structural grade hardwood timber of sizes that sustain spans and maintain stability. Refer to drawn details for further information.

SOFTWORKS

Site Soil Testing

Where site soil is to be retrieved from site and stored on site for reuse, undertake at least two (2) soil tests in locations as advised by the Project Manager or as shown on the plans. Provide results and recommendations regarding soil additives for the benefit of healthy plant growth and to adjust the soil components to achieve an appropriate planting medium for successful plant development. Where topsoil is imported to site no testing of the imported soil is necessary but ensure that imported soil can be supplied with test data to verify that it suits the design plants.

Excavate and/or fill all garden beds to bring the top of subsoil to at least 300mm below finished design soil levels. Excavate all turf areas to bring the subsoil to at least 100mm below finished design levels. In all areas shape the subsoil to fall to subsoil drains where applicable. Do not excavate within the drip line of trees and shrubs to be retained. Cultivate or rip the subsoil to a further depth of 100mm before placing top soil. Remove stones of size exceeding 25mm, clods of earth exceeding 50mm, and weeds, rubbish or other deleterious material brought to the surface during cultivation. Do not disturb services or existing tree roots. If necessary, cultivate these areas by hand. During cultivation, thoroughly mix in materials required to be incorporated into the subsoil, as recommended in the soil testing results and to manufacturer's recommendations. Trim the surface to design levels again after cultivation.

Subsoil Drainage

Provide and install subsoil drainage equal to Vinidex 65mm (min) Draincoil with filter sock at the base of slopes, on the high side of paths, at the base behind retaining walls and where water is likely to accumulate at depth in the soil. Connect all subsoil drainage to the nearest downstream stormwater pit to ensure that subsoil water is managed and channelled to a stormwater drainage system. On sites with cross fall of less than 1:50 install subsoil drains to remove excess water from the subsoil in areas where water is likely to accumulate and may not penetrate lower strata naturally. Rip the sub-base surface 150mm deep before placing any soil. Install drainage pipes in subsoil trenches backfilled with 10mm blue metal (basalt) equal to ANL Blue Metal.

Coordinate the connection of subsoil drains to stormwater pits with the Civil or Hydraulic contractor.

Import topsoil for the garden and turf areas, unless the topsoil can be provided from material recovered from the site, as recommended in the soil testing results. Spread the topsoil on the prepared subsoil and grade evenly, compact lightly and uniformly in 150mm layers. Avoid differential subsidence and excess compaction and produce a finished topsoil surface which has the following characteristics:

- Finished to design levels, allowing for mulch or turf, which is to finish flush with adjoining hard surfaces such as paths
- and edges; Smooth and free from inorganic matter, stones or clods of soil;
- Graded to drain freely, without ponding, to catchment and/or sub-soil drains;
- Graded evenly to adjoining surfaces; and Ready for planting.

Provide, in accordance with AS 4454, well rotted vegetative material or animal manure, free from harmful chemicals, inorganic matter, grass, weeds and the reproductive parts of unwanted plants.

Fertiliser

Provide proprietary fertilisers, delivered to the site in sealed containers marked to show manufacturer or vendor, weight, fertiliser type, N:P:K ratio, recommended uses, application rates and safety procedures. Apply appropriate fertiliser suited

to the provenance of plants (indigenous or exotic) included in the design.

Supply plants in accordance with the landscape design drawings and schedules, which have the following characteristics:

• Large healthy root systems, with no evidence of root curl, restriction or damage;

- Hardened off, not soft or forced, and suitable for planting in the natural climatic conditions prevailing at the site in full sun, partial shade or full shade conditions;
- Containers shall be free from weeds and of appropriate size in relation to the specified plant size.

Following excavation of the planting hole, place and spread 15gms of wetting agent pre-mixed with one (1) litre of water. Place the plant correctly orientated to north or for best presentation. Backfill the planting holes with specified topsoil mixture. Lightly tamp and water to eliminate air pockets. Ensure that the backfill soil is not placed over the top of the root ball and that the root ball is not higher than the soil in which it is planted. Apply fertiliser, as specified around the plants in the soil at the time of planting.

Embankment Stabilisation

Where necessary and shown on the drawings prevent soil erosion or soil movement by stabilising embankments as follows. As a minimum, this should be on slopes steeper than or equal to 1:3 gradient. Stabilise embankments using biodegradable fibre reinforced heavy weight jute fabric. Lay fabric from top to bottom of slope. Install in accordance with manufacturer's specification, including 300 x 300mm anchor trench at top and bottom of slope, backfilled with soil over the fabric and compacted into the trenches. Using U-shaped galvanised steel pegs at 1000 mm centres generally and 250mm centres at edge overlaps, secure the fabric to the prepared soil surface. Plant through the fabric after it is installed.

Root Barrier

Supply and install root control barriers to all new tree plantings adjacent to walls, paths, kerbs and all service trenches, where their proximity poses a threat to the stability of the built infrastructure. Install in accordance with manufacturer's recommendations.

Mulch

Unless noted otherwise, mulch shall be approved proprietary recycled wood fibre or pine bark material. Place mulch in all garden beds to a depth of 75mm after all specified plants are installed. Keep mulch clear of all plant stems and rake to an even plane, flush with the surrounding surfaces evenly graded between design surface levels. Over fill to allow mulch to settle to the specified depth.

Stakes and Ties

Stakes shall be durable hardwood, straight, free of knots and twists, pointed at one end, in the following quantities and

- sizes for each of the various plant pot sizes: Plants >25 lt: 1 off 38 x 38 x 1200mm;
- Semi-advanced plants >75 lt: 2 off 50x50x 1800mm;
- Advanced plants >100 lt: 3 off 50 x 50 x 2400mm.

Turf shall be delivered to site as 25mm minimum thick cut rolls. Obtain turf from a specialist grower of cultivated turf. Turf shall have an even thickness, free from weeds and other foreign matter. Deliver turf to the site within 24 hours of being cut and lay it within 24 hours of delivery. Prevent it form drying out between cutting and laying. Lay the turf in the following manner:

- In stretcher pattern, joints staggered and close butted;
- Parallel long sides of level areas, with contours on slopes; and To finish flush, after lightly tamping, with adjacent finished surfaces and design levels.
- Species: Stenotaphrum secundatum Sir Walter Soft-leaf Buffalo.

IRRIGATION

Scope: Unless otherwise noted or instructed irrigate all planted areas shown on plans including planters, tubs, gardens, turf and the like. The irrigation system shall be an automatic permanent system, with an irrigation controller self operated via a soil moisture sensor. The system shall be calibrated to deliver the optimum rate and volume of water appropriate to the type of plants in the design. The system shall be adjustable and fully serviceable. The layout of the entire irrigation system shall focus on delivering the required amount of water to maintain healthy and vigorous growth. The irrigation system shall be such that, component theft, vandalism, over-spray and wetting of paths shall be reduced to a minimum or eliminated with the use of drip, pop-up sprinklers and judiciously placed fixed spray emitters. Generally, do not use fine mist emitters that provide a drifting mist that may wet paths and the buildings unless specifically required by the design.

The Landscape Contractor shall engage a qualitied irrigation consultant to design the system, document all components, accessories and materials for review by the Landscape Architect prior to starting landscape works generally.

LANDSCAPE MAINTENANCE

The Landscape Contractor shall rectify defects during installation and that become apparent in the works under normal use for the duration of the contract Defects Liability Period. Unless contracted otherwise, the Landscape Contractor shall maintain the contract areas by the implementation of industry accepted horticultural practices for 52 weeks from Practical Completion of the works. The landscape maintenance works shall include, but not be limited to:

- Replacing failed plants;
- Pruning;
- Insect and pest control; Fertilising;
- Maintaining and removing stakes and ties;
- Maintaining mulch;
- Mowing and top dressing; Irrigation and watering;
- Erosion control; and Weeding and rubbish removal.

Maintenance Log Book

Implement and keep a maintenance log book recording when and what maintenance work has been undertaken and what materials, actions and decisions have been used, implemented and concluded to keep the landscape always looking its best. Enter data daily and review information every 2 weeks. Observe trends and develop a maintenance regime around seasonal and observed event occurrences.

During the defect maintenance period schedule the following activities to occur on a timely basis.

Plant replacement - Replace plants that have failed to mature, die or are damaged. Replacement plants shall be in a similar size and quality and identical species or variety to the plant that has failed. Replacement of plants shall be at the cost of the landscape contractor unless advised otherwise. If the cause of the failure is due to a controllable situation then correct the situation prior to replacing plants. Observe and replace failed plants within 2 weeks of observation.

Pruning - Prune dead wood, broken limbs, dead or infected foliage and as needed to develop strong, healthy plants to achieve the shape and form expected of the plant type. Observe daily and prune plants as necessary to maintain acceptable growth habit.

Insect, disease and pest control - Avoid spraying:

- if ever possible;
- in wet weather or if wet weather is imminent;
- if target plants are still wet after rain; in windy weather; and
- if non-target species are too close.

Immediately report to the Project Manager any evidence of intensive weed infestation, insect attack or disease amongst plant material. Submit all proposals to apply chemicals and obtain approval before starting this work. When approved, spray with herbicide, insecticide, fungicide as appropriate in accordance with the manufacturers' recommendations. Observe daily and act as necessary to control any infestation or disease. Record in the logbook all relevant details of spraying activities including:

- Product brand / manufacturer's name,
- Chemical / product name,
- Chemical contents, Application quantity and rate,

- Vigorous, well established, free from disease and pests, of good form consistent with the species/variety;
- Grown in final containers for not less than twelve weeks;
- Trees, unless required to be multi-stemmed, shall have a single leading shoot; and

Plant Installation

the end of the planting establishment period (Defects Liability Period). Inspect and act at least every 2 weeks. Maintaining mulch - Maintain the surface in a clean, tidy and weed free condition and reinstate the mulch as necessary

Stakes and ties - Adjust and replace as required to ensure plants remain correctly staked. Remove those not required at

Fertilise gardens with a proprietary slow release fertiliser applied in accordance with the manufacturer's directions and

recommendations. Apply 6-12 monthly. Record in the logbook all relevant details of fertilising including:

to ensure correct depth as specified. Observe weekly and replenish mulch as required.

Date of application and location,

Product brand / manufacturer's name.

Application quantity and rate, and

Date of application and location.

Results of application, and

Use approval authority.

Fertiliser / product name,

Mowing and top dressing - Mow the turf to maintain a grass height of between 30-50mm. Do not remove more than one third of the grass height at any one time. Remove grass clippings from the site after each mowing. Top dress to a maximum of 10mm to fill depressions and hollows in the surface. Mow weekly/fortnightly in warmer months. Mow monthly or as required in cooler months. Top dress at approximately 6 monthly intervals.

Irrigation and watering - Maintain the irrigation system to sure that each individual plant receives the required amount of water to maintain healthy and vigorous growth. Adjust and calibrate as required. Provide additional watering, if necessary but inspect irrigation weekly and make repairs as necessary.

Erosion control - Where necessary, maintain the erosion control fabric in a tidy and weed free condition and reinstate as necessary to ensure control measures are effective where deemed necessary. Inspect every 2 weeks and act to repair any damage as soon as possible

Weeding and rubbish removal - During the plant establishment period remove by hand, rubbish and weed growth that may occur or re-occur throughout all planted, mulched and paved areas. The contractor shall target weeds that are capable of producing a major infestation of unwanted plants by seed distribution. Whenever possible, time weed removal to precede flowering and seed set. Constant observation and removal of weeds is essential.

	d Floor - Plant Schedule			na	lan i	
Symbol	Botanical Name	Common Name	Indigenous	Mature Height (m.)	Mature Spread (m.)	Potsize
treet Ti Csa	rees Callistemon salignus	Weeping bottlebrush	*	7	5	200L
Mda	Melaleuca decora	White feather honeymyrtle	*	7	5	200L
	Weight description	Trince loading heriographic				
rees &	Palms					
Ар	Acer palmatum	Japanese Maple		6	3	100L
Asm	Acmena smithii	Lily Pilly	*			
As	Angophora subvelutina	Broad-leaved Apple	*			100L
Af	Angophora floribunda	Rough-barked Apple	*	_		100L
Bm	Backhousia myrtifolia	Lemon scented myrtle	*	7	4 -	100L
Cga	Corymbia gummifera	Red bloodwood	*	20 12	5 7	100L 200L
Ca Cas	Cupaniopsis anacardioides Cyathea australis	Tuckeroo Rough tree fern	*	4	3	100L
Ee	Elaeocarpus eumundii	Quandong	*	15	5	100L
Er	Elaeocarpus reticulatus	Blueberry Ash	*	12	4	100L
Ef	Eucalpytus fibrosa	Broad leaf ironbark	*	25	8	100L
Ea	Eucalyptus amplifolia	Cabbage Gum	*			100L
Eb	Eucalyptus baueriana	Blue Box	*			100L
Et	Eucalyptus tereticornis	Forest Red Gum	*			100L
Es	Eucalyptus saligna	Blue Gum	*			100L
Er	Eucalyptus robusta	Swamp Mahogany	*			100L
Em	Eucalyptus moluccana	Grey Box	*			100L
Fru	Ficus rubiginosa	Port Jackson Fig	*	30	15	100L
HtR	Hibiscus tiliaceus 'Rubra'	Cottonwood	*	5	3.5	100L
Hf	Hymenosporum flavum	Native frangipani	*	8	6	100L
LiN	Lagerstroemia indica 'Natchez' Lophostemon conferta	Crepe Myrtle Brush Box	*	6 8	5	200L 100L
Lc Me	Lophostemon conferta Magnolia exmouth	Bull bay magnolia	*	12	7	100L 100L
MLG	Magnolia grandiflora 'Little Gem'	Dwarf Magnolia		5	3	100L
Md	Melaleuca decora	White Feather Honeymyrtle	*		+	100L
Ms	Melaleuca styphelioides	Prickly-Leaved Paperbark	*			100L
MI	Melaleuca linarifolia	Snow in Summer	*			100L
Рс	Pyrus 'Capital'	Pear tree		12	3	100L
Sga	Syncarpia glomulifera	Turpentine	*	35	10	100L
П	Tristaniopsis laurina	Water Gum	*	10	7	100L
Up	Ulmus parvifolia	Weeping Elm		10	4	100L
Wf	Waterhousia floribunda	Weeping Lily Pilly		15	5	100L
Shrub &	Accent Planting					
Ah	Acmena 'Hot Flush'	Dward Lily Pilly	*	3	1.5	300mm
AsS	Acmena 'Sublime'	Acmena Sublime	*	3.5	2.5	300mm
BmJ	Buxus macrophylla japonica	Buxus	*	1	1 1	300mm
CW	Callistemon citrinus White Anzac'	Lemon Scented Bottlebrush	*	3	2 2.5	300mm 300mm
Css CRS	Callistemon salignus Cordyline 'Red Sensation'	Willow bottlebrush Red Cordyline		5.5	1	300mm
De	Doryanthes excelsa	Gymea Lily	*	3	2	300mm
GaF	Gardenia augusta 'Florida'	Gardenia		0.5	1.5	300mm
Gr	Grevillea rosmarinifolia	Rosemary Grevillea	*	1.5	1.5	300mm
LCP	Loropetalum 'China Pink'	Chinese Frince Flower		2	1.5	300mm
MCT	Melaleuca 'Claret Tops'	Claret Tops	*	1.8	1.8	300mm
Mf	Michelia figo	Port Wine Magnolia		3	3	300mm
Мр	Murraya paniculata	Orange Jasmine		3	2.5	300mm
Px	Philodendron xanadu	Xanadu		0.7	0.7	300mm
PgR	Photinia glabra 'Rubens'	Dwarf Photinia		1.8	1.8	300mm
PML	Plectranthus 'Mona Lavender'	Mona Lavender	*	0.7	0.7	300mm
Pp	Plectranthus parvifolium Rhaphiolenis 'Oriental Pearl'	Plectranthus Oriental Pearl	*	0.5	0.5	300mm 300mm
ROP RSM	Rhaphiolepis 'Oriental Pearl' Rhaphiolepis 'Snow Maiden'	Oriental Pearl Snow Maiden		0.6	0.8	300mm 300mm
Sg	Strobilanthes gossypinus	Persian Shied		1.5	1.5	300mm
SaP	Syzygium australe 'Pinnacle'	Pinnacle	*	3	1.5	300mm
Vo	Viburnum odoratissimum	Sweet Vibumum		4	2	300mm
WWG	Westringia Wynyabbie Gem'	Wynyabbie Rosemary	*	1	1	300mm
\	9. Oranization					
	& Groundcovers	Now Zooland Dook 19		0.0	1 4	150
Aci	Arthropodium cirratum	New Zealand Rock Lily	*	0.8	0.9	150mm 150mm
Cg Cmi	Carpobrotus glaucescens Clivea miniata	Pig Face Kaffir Lily		0.2	0.9	150mm
Com	Convolvulus mauritanicus 'Blue Moon'	Morning Glory		0.43	0.9	150mm
DB	Dianella 'Breeze'	Breeze Flax Lily	*	0.7	0.6	150mm
Dca	Dianella caerulea	Flax lily	*	0.5	0.5	150mm
DSS	Dianella 'Silver Streak'	Silver Streak Flax Lily	*	0.5	0.4	150mm
Dg	Dietes grandiflora	Wild Iris	*	0.7	0.7	150mm
Hs	Hibbertia scandens	Snake Vine	*	4	3	150mm
LJR	Liriope muscari 'Just Right'	Turf Lily		0.5	0.5	150mm
LT	Lomandra longifolia 'Tanika'	Tanika Mat Rush	*	0.7	0.7	150mm
LI	Lomandra longifolia	Mat rush	*	1	0.8	150mm
	Myoporum parvifolium	Creeping Boobialla	*	0.2	0.8	150mm
Му		10	Ī	0.8	0.8	150mm
PN	Pennisetum 'Nafray'	Swamp Foxtail				
	Pennisetum 'Nafray' Themeda australis Trachelospermum jasminoides	Kangaroo grass Star Jasmine	*	0.8	0.5	150mm 150mm

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The contractor shall check and verify all work on site (including work by others) before commencing the landscape installation. Any discrepancies are to be reported to the Project Manager or Landscape Architect prior to commencing work. Do not scale this drawing. Any required dimensions not shown shall be referred to the Landscape Architect for confirmation.

F	For Approval	MJW	RS	05.04.2023
Ε	For Approval	MJW	RS	03.03.2023
D	For Approval	PH	RS	13.02.2023
С	For Approval	PH	RS	01.02.2023
В	For Approval	PH	RS	16.01.2023
Α	For Approval	PH	RS	23.11.2022
Issue	Revision Description	Drawn	Check	Date

Legend

Key Plan



Lateral Estate

Level 1, 3-5 Baptist Street

ABN 44 801 262 380

31-33 SHEPHERD STREET LIVERPOOL

SITE IMAGE


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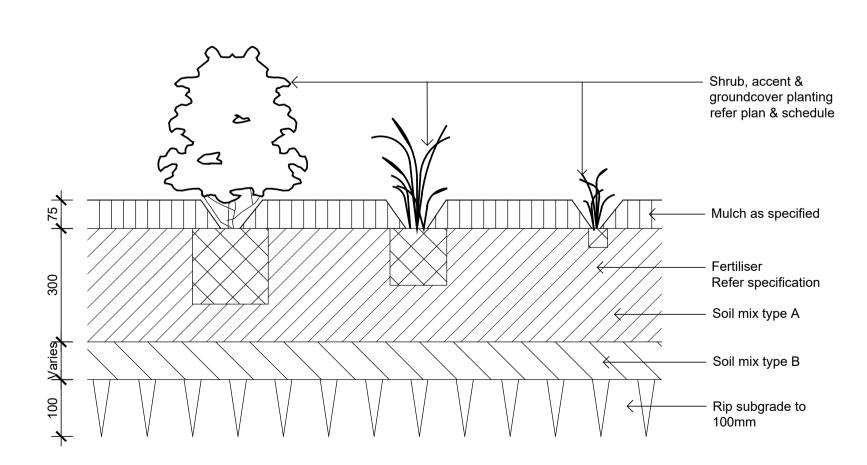
Landscape Specification

Job Number


SS22-5066



Detail 75-200L Tree Planting on Structure 501 / 1:10

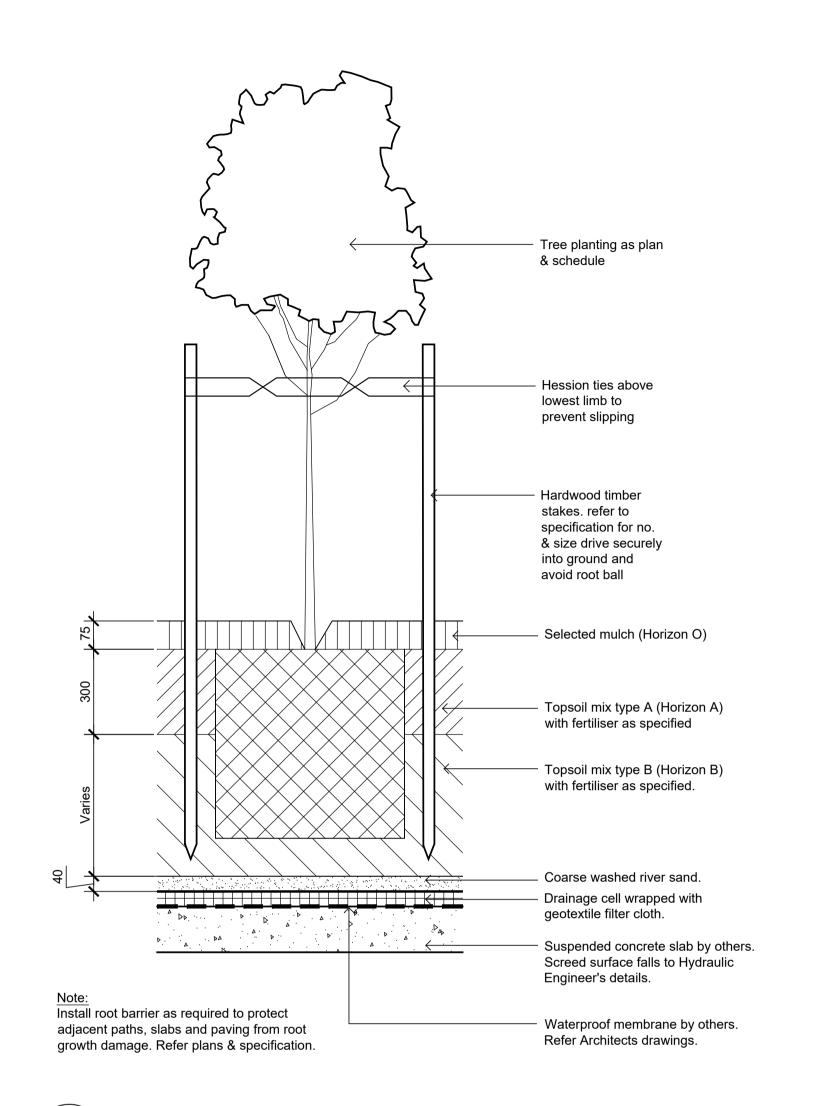


Detail Shrub Accent & Groundcover Planting on Grade 501 1:10

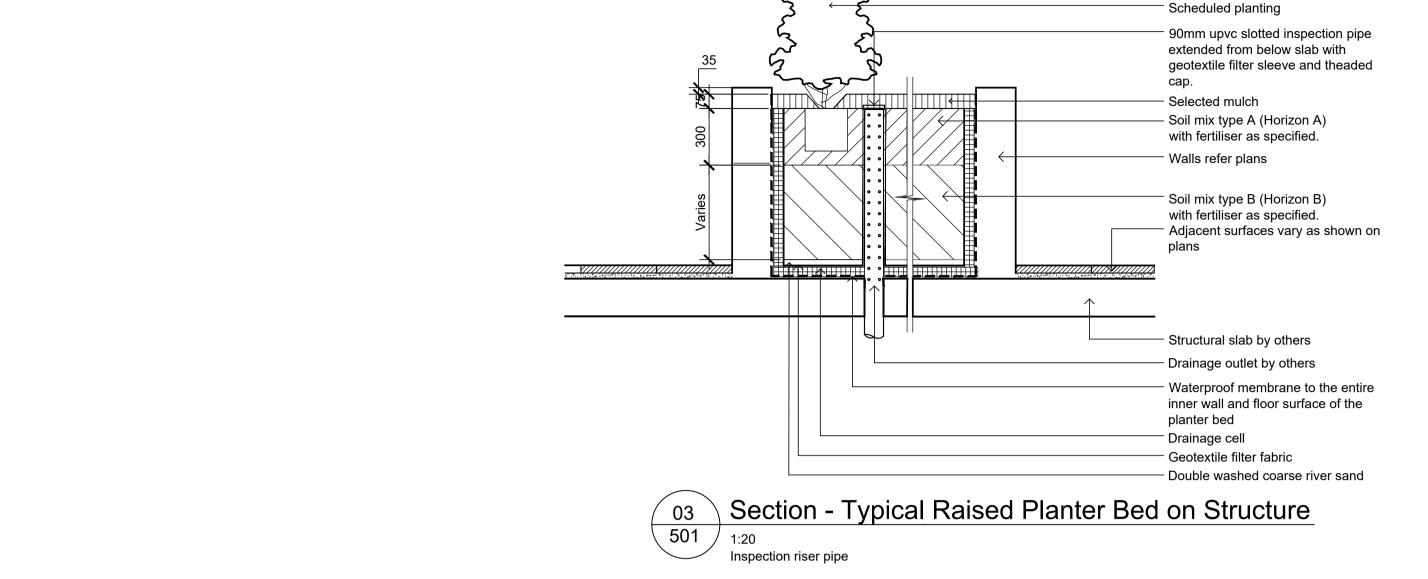


Refer to plans for adjacent surfaces and edging In-situ reinforced concrete paving slab. ✓ Fall to free √ edges Waterproof membrane Compacted base course Compacted sub-grade to an even surface that allows the finished paving to meet design


Insitu Concrete Paving - On grade 501 1:10

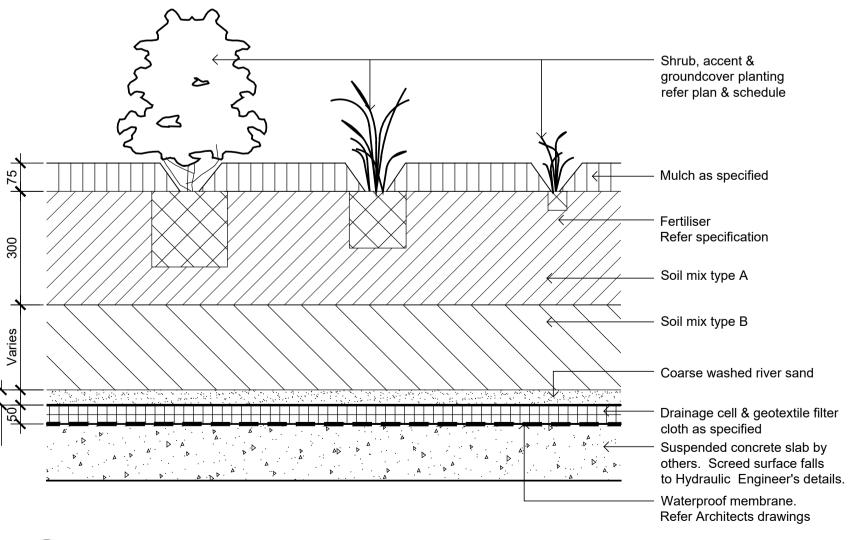

501 1:10

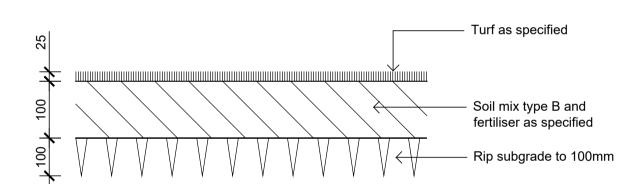

Detail Turf on Even Grade 501 / 1:10

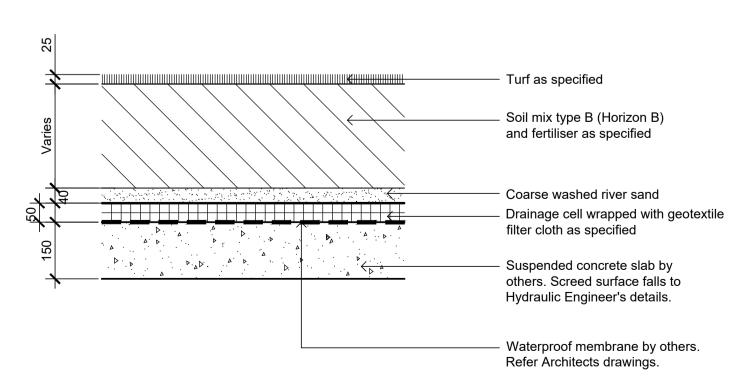

Detail Turf on Suspended Structure 501

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F For Approval MJW RS 05.04.2023 For Approval MJW RS 03.03.2023 For Approval PH RS 13.02.2023 For Approval PH RS 01.02.2023 B For Approval PH RS 16.01.2023 PH RS 23.11.2022 A For Approval Issue Revision Description Drawn Check Date

Legend

Key Plan



Lateral Estate

31-33 SHEPHERD STREET LIVERPOOL

SITE IMAGE

Level 1, 3-5 Baptist Street Redfern NSW 2016 Australia

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DEVELOPMENT APPLICATION

Drawing Name Landscape Details

Job Number

Scale As Shown

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